



Section A-A Scale 1:100



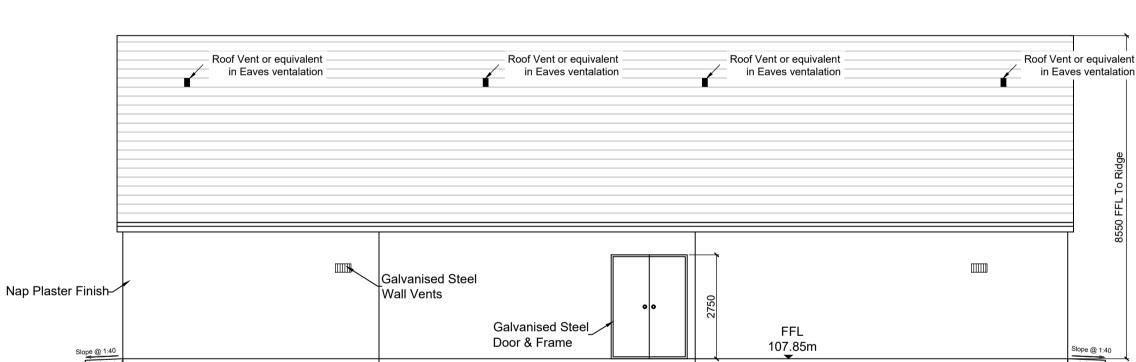

Front Elevation - West Scale 1:100

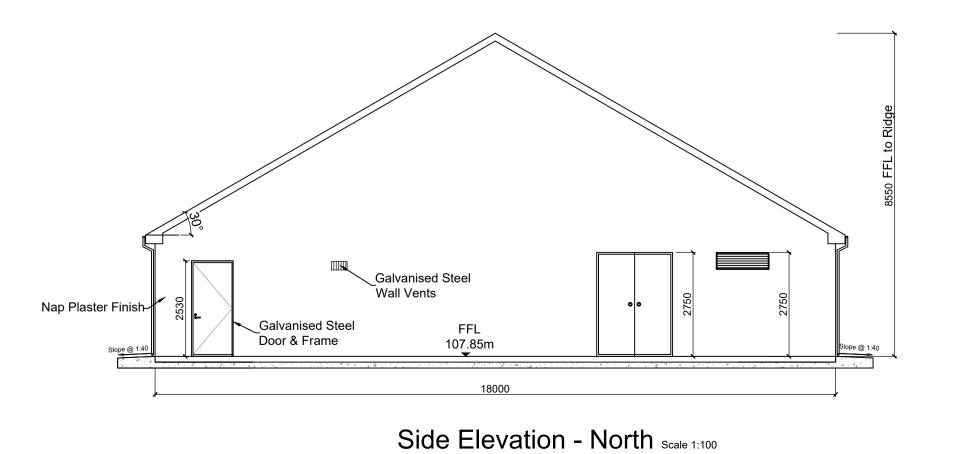

Roof Vent or equivalent in Eaves ventalation

Galvanised Steel Wall Vents

Galvanised Steel Door & Frame

Galvanised Steel Door & Frame

107.85m

Rear Elevation - East Scale 1:100

DO NOT SCALE FROM THIS DRAWING. USE FIGURED DIMENSIONS IN ALL CASES. VERIFY DIMENSIONS ON SITE AND REPORT ANY DISCREPANCIES TO THE DESIGNERS IMMEDIATELY.

THIS DRAWING TO BE READ IN CONJUNCTION WITH THE DESIGNERS SPECIFICATION.

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NOTES:

. ALL DRAWINGS ARE TO BE READ IN CONJUNCTION WITH ALL RELEVANT SPECIFICATIONS, BILLS OF QUANTITIES, ARCHITECTURAL, SERVICES AND ENGINEERING DRAWINGS.

- 2. ALL LEVELS ARE IN METRES RELATED TO ORDNANCE DATUM MALIN HEAD.
- 3. ANY DISCREPANCIES BETWEEN THESE DOCUMENTS SHALL BE BROUGHT TO THE ATTENTION OF THE ENGINEER.
- 4. DRAWINGS ARE NOT TO BE SCALED.
- 5. ALL DIMENSIONS ARE IN MILLIMETRES, UNLESS NOTED OTHERWISE.

**Brittas Wind Farm** 

TITLE:

EirGrid Building - Plan & Elevations & Section

CLIENT:

Brittas Wind Farm Ltd.



DRAWN:	CHECKED:	APPROVED:
JK	CMcL	PC
PROJECT NUMBER:	DATE:	SCALE @ A1:
23318	June 2024	1 : 100
STATUS DESCRIPTION		STATUS:
FOR INFORMATION		S2

RAWING NUMBER: REV: 23318 - MWP - 00 - 00 - DR - C - 5421 PC